DRAINAGE CALCULATIONS:

DRAINAGE PLAN

THIS DRAINAGE PLAN IS FOR A NEW RESIDENCE AT 7410 CORRALES ROAD, IN TRACT B, LANDS OF SHADUR, VILLAGE OF CORRALES, SANDOVAL COUNTY, NEW MEXICO, CONTAINING THE FOLLOWING ITEMS FOR THE GRADING AND DRAINAGE PLAN ARE CONTAINED HEREON:

- DRAINAGE CALCULATIONS
- VICINITY MAP
- FLOOD INSURANCE RATE MAP 35043C1913D
- GRADING PLAN

EXISTING CONDITIONS

AS SHOWN BY THE VICINITY MAP, TRACT B CONTAINS APPROXIMATELY 1.0034 ACRES AND IS CURRENTLY VACANT LAND. AS SHOWN ON THE FLOOD INSURANCE RATE MAP NUMBER 35043C1913D, THE ENTIRE TRACT IS WITHIN A 100-YEAR FLOODPLAIN WITH DESIGNATION ZONE AO (DEPTH 2'). THE SITE'S EXISTING TOPOGRAPHY IS A FLAT SITE THROUGH THE ENTIRE TRACT.

PROPOSED CONDITIONS:

THE PROPOSED PLAN IS TO CONSTRUCT A NEW RESIDENCE THAT WILL CONSIST OF APPROXIMATELY 2,853SF NEAR THE WESTERN EDGE OF TRACT B. THE PLAN IS TO ELEVATE THE STRUCTURE'S PAD 2 FEET ABOVE THE HIGHEST EXISTING ADJACENT GRADE TO MEET FEMA CRITERIA

FOR REFERENCE THE GRADE ALONG THE NORTH PROPERTY LINE WAS USED WITH AN EXISTING ELEVATION OF 5028.74 FEET (THE HIGHEST GRADE ON THE NORTH PROPERTY LINE) AND WILL MAKE THE PAD ELEVATION ADJACENT TO THE STRUCTURE AT AN ELEVATION OF 5030.90 FEET. THIS WILL RESULT IN THE PAD BEING APPROXIMATELY 2.16 FEET ABOVE THE HIGHEST ADJACENT GRADE. THE FINISH FLOOR OF THE STRUCTURE WILL BE SET AT AN ELEVATION OF 5031.20 FEET, WHICH IS 2.46 FEET ABOVE THE HIGHEST ADJACENT GRADE AND WILL MEET OR EXCEED FEMA CRITERIA FOR THIS DESIGNATED FLOOD ZONE OF 2 FEET.

AS PER THE VILLAGE OF CORRALES PLANNING AND ZONING DEPARTMENT APPLICATION FOR THE CONSTRUCTION BUILDING PERMIT THE PLAN SUBMISSION WILL FOLLOW ITEM 6D. SITE PLAN REQUIREMENTS. THE DRAINAGE AND GRADING PLAN WILL INCLUDE AN ON-SITE RETENTION POND FOR IMPERVIOUS SURFACE CONDITIONS. THE POND SIZE IS CALCULATED AT: TOTAL AREA OF IMPERVIOUS SURFACE ON THE LOT X 2.66. / 12 = CUBIC FEET IS THE VOLUME OF WATER THAT MUST BE RETAINED IN AN ON SITE POND.

DRAINAGE CALCULATIONS

I. ANALYZE NORTH ROOF DRAINAGE POND SIZE:

IMPERVIOUS ROOF AREA = 1,776SF

VOLUME REQUIRED = 1,776SF X 2.99 / 12 = 443CF POND VOLUME REQUIRED FOR

POND AT NE CORNER OF HOUSE

POND VOLUME PROVIDED = ((581SF @ 5027ELEV) + (275SF @ 5026.5 ELEV))/2 X 0.5' DEPTH + ((581SF @ 5027ELEV) +

(1,127SF @ 5028ELEV))/2 X 1.0'DEPTH = 1,068CF PROVIDED > 443CF REQUIRED OK

2. ANALYZE SOUTH ROOF DRAINAGE POND SIZE:

IMPERVIOUS ROOF AREA = 1,100SF

VOLUME REQUIRED = 1,100SF X 2.99 / 12 = 274CF POND VOLUME REQUIRED FOR


POND AT SE CORNER OF HOUSE


POND VOLUME PROVIDED = ((200SF @ 5026.5ELEV) + (578SF @ 5027ELEV))/2 X 0.5'DEPTH + ((578SF @ 5027ELEV) +


(2,746SF @ 5028ELEV))/2 X 1.0'DEPTH = 1,907CF PROVIDED > 274CF REQUIRED OK

EROSION CONTROL NOTES:

- 1. CONTRACTOR IS RESPONSIBLE FOR OBTAINING A PLANNING AND ZONING PERMIT FROM THE VILLAGE OF CORRALES PRIOR TO BEGINNING WORK.
- 2. CONTRACTOR IS RESPONSIBLE FOR MAINTAINING RUN-OFF ON SITE DURING CONSTRUCTION.
- 3. CONTRACTOR IS RESPONSIBLE FOR CLEANING ALL SEDIMENT THAT GETS INTO EXISTING RIGHT-OF-WAY.
- 4. REPAIR OF DAMAGED FACILITIES AND CLEANUP OF SEDIMENT ACCUMULATIONS ON ADJACENT PROPERTIES AND IN PUBLIC FACILITES IS THE RESPONSIBILITY OF THE CONTRACTOR.
- 5. ALL EXPOSED EARTH SURFACES MUST BE PROTECTED FROM WIND AND WATER EROSION PRIOR TO FINAL ACCEPTANCE OF THIS PROJECT

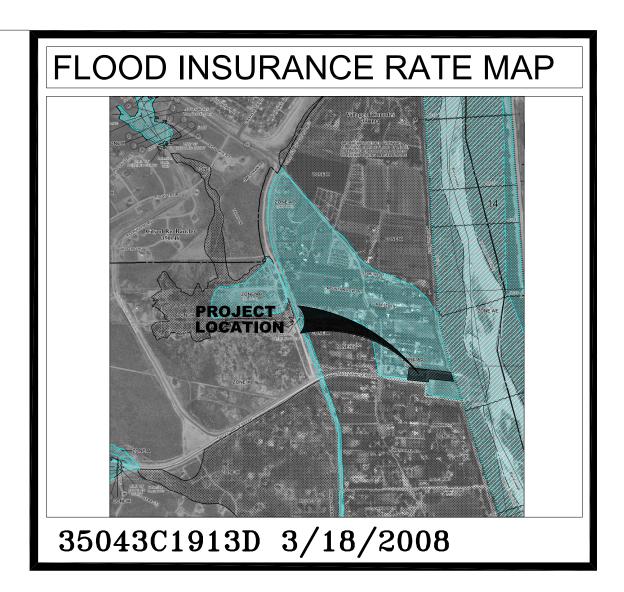

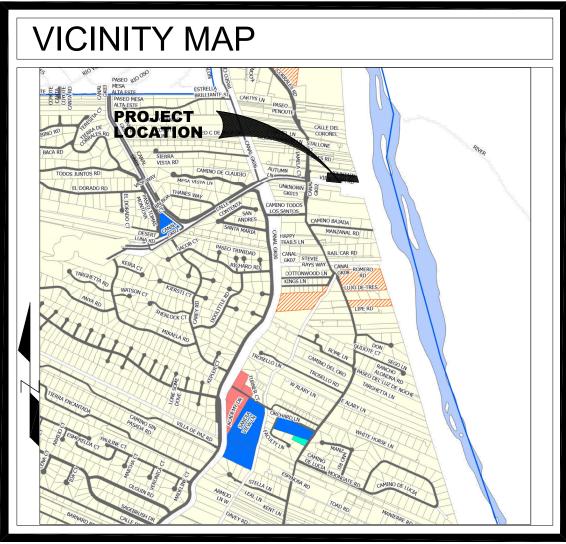


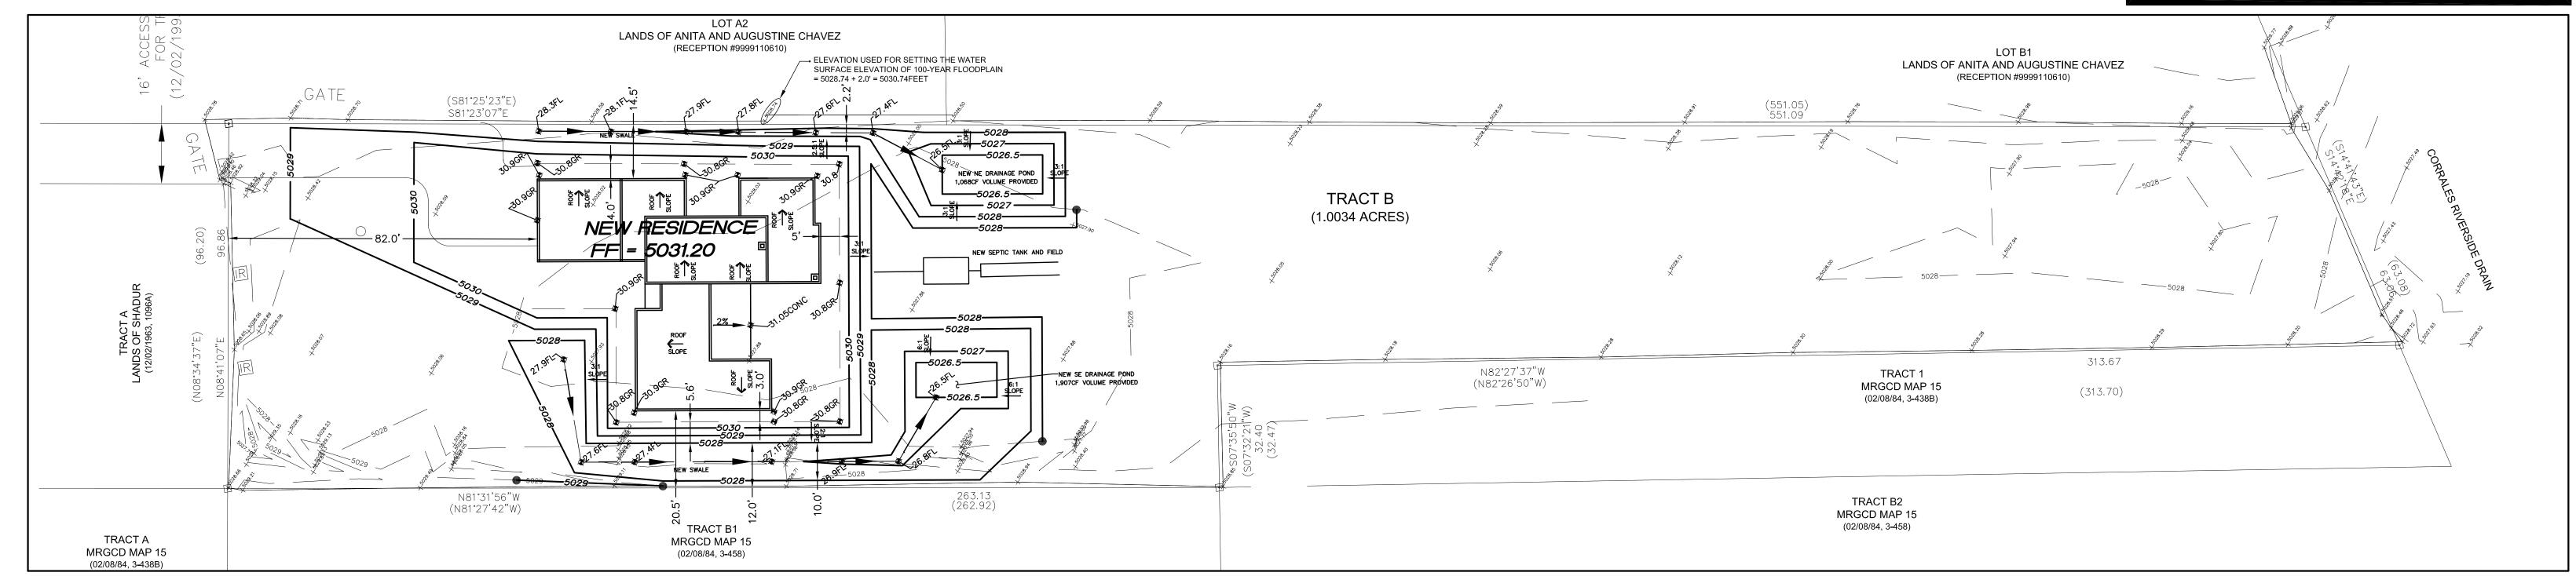

LEGEND EXISTING TOP OF CURB ELEVATION ---- NEW FINAL SURFACE GRADE - - - 6514 - _ _ EXISTING CONTOUR GRADE EXISTING FLOWLINE ELEVATION DRAINAGE FLOW DIRECTION NEW SURFACE GRADE ELEVATION NEW TOP OF CURB ELEVATION FLOWLINE SWALE ELEVATION NEW TOP OF WALL ELEVATION NEW FLOWLINE OF CURB ELEVATION NEW TOP OF ASPHALT ELEVATION NEW BOTTOM OF WALL ELEVATION AT ADJACENT GRADE NEW TOP OF SIDEWALK ELEVATION DRAINAGE SWALE

GRADING PLAN


SCALE 1" = 20'

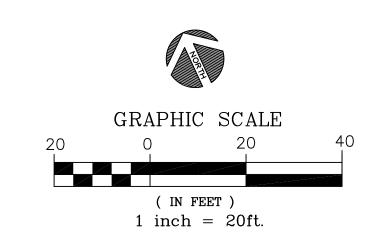

EXCAVATION/UTILITY NOTES:

ITHE ENGINEER HAS UNDERTAKEN NO FIELD VERIFICATION OF THE

LOCATION, DEPTH, SIZE OR TYPE OF EXISTING ABOVE AN UNDERGROUND UTILITIES, OR EXISTING PIPELINES. THE ENGINEER MAKES NO REPRESENTATION PERTAINING THERETO, AND ASSUMES NO RESPONSIBILITY OR LIABILITY THEREFOR. THE CONTRACTOR SHALL INFORM HIMSELF OF THE LOCATION OF ANY EXISTING ABOVE AND UNDERGROUND UTILITIES, AND EXISTING PIPELINES, IN AND NEAR THE AREA OF THE WORK, IN ADVANCE OF AND DURING EXCAVATION WORK. THE CONTRACTOR IS FULLY RESPONSIBLE FOR ANY AND ALL DAMAGE CAUSED BY HIS FAILURE TO LOCATE, IDENTIFY AND PRESERVE ANY AND ALL EXISTING ABOVE AND UNDERGROUND UTILITIES, AND EXISTING PIPELINES. THE CONTRACT SHALL COMPLY WITH STATE STATUES PERTAINING TO THE LOCATION OF THESE LINES IN PLANNING AND CONDUCTING EXCAVATION WORK.

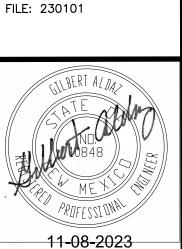

GRADING AND DRAINAGE PLAN 7410 CORRALES ROAD **ED CHURCH & LAURA SCOTT**

APPLIED Engineering & Suveying, Inc. 1605 BLAIR DRIVE NE, ALBUQUERQUE NEW MEXICO 87112, galdaz47@yahoo.com, (505)480-8125 DATE/REVISIONS:

SHEET NUMBER: